
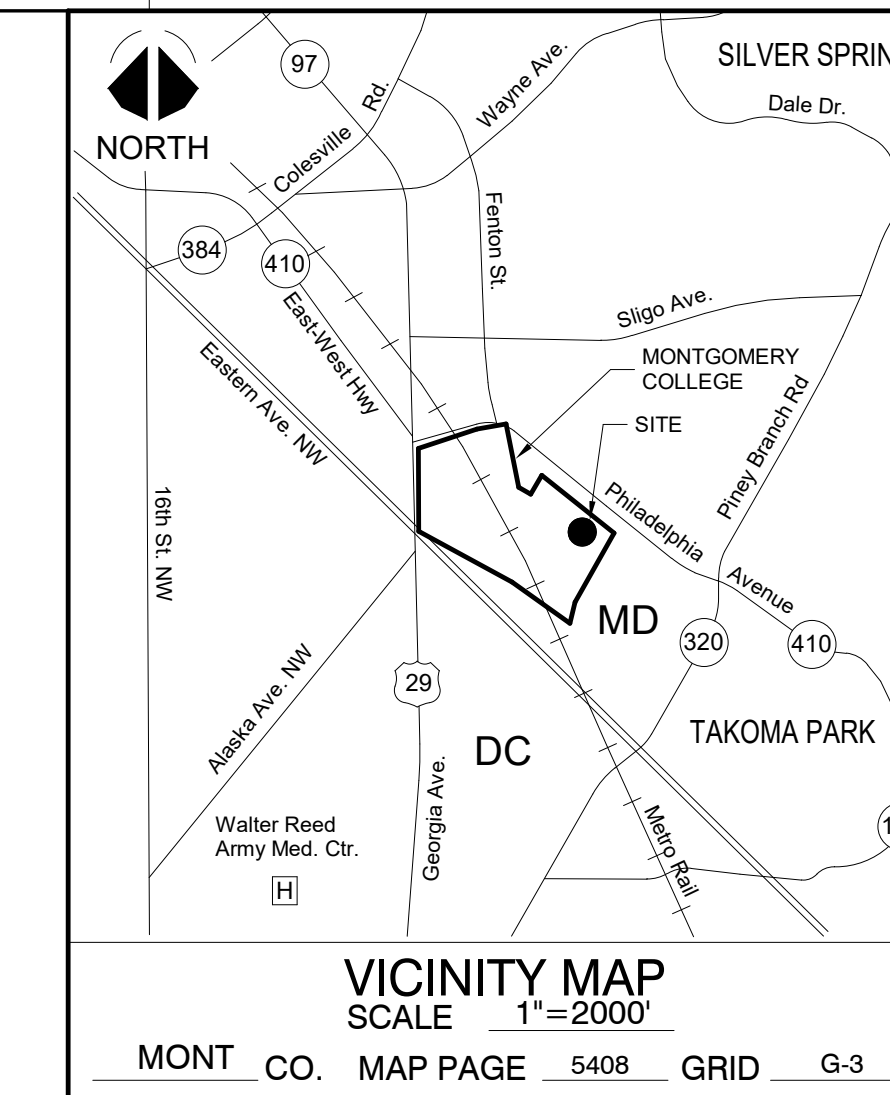
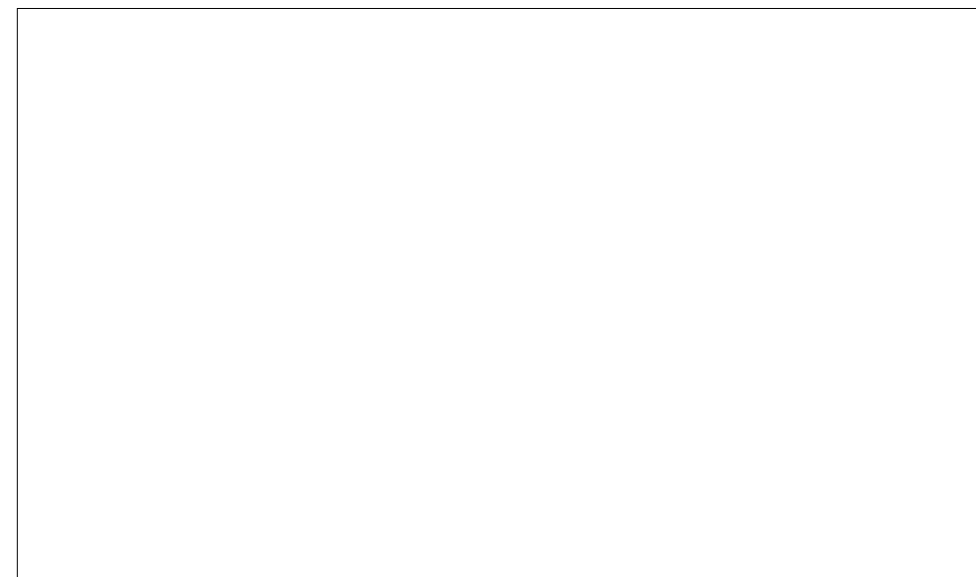


M-NCPPC APPROVAL STAMP:

PROPERTY OWNERS CERTIFICATE:

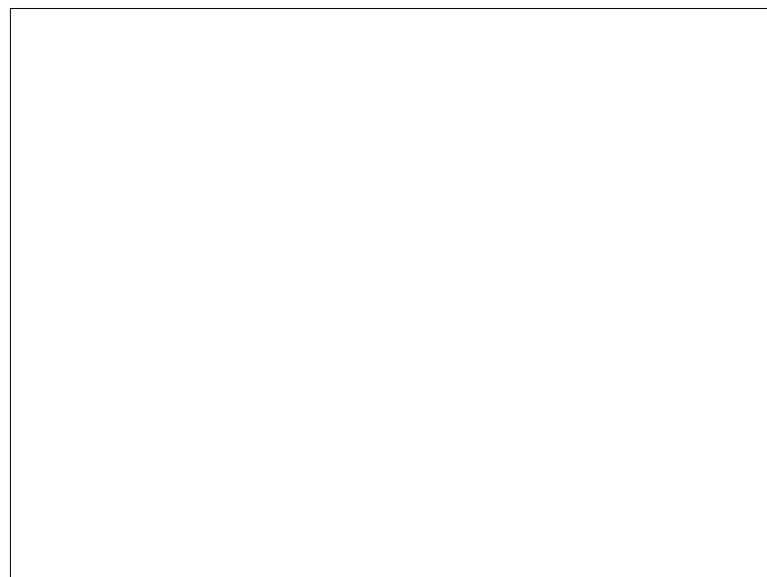

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LEGEND

	LIGHTING FIXTURE TYPE DESIGNATION. "1" INDICATES SPECIFIC FIXTURE TYPE. "X" INDICATES SPECIFIC DISTRIBUTION OPTIC. REFERENCE LUMINAIRE SCHEDULE FOR ADDITIONAL SPECIFICATIONS
	LIGHTING FIXTURE AIMING/DIRECTIONAL INDICATION
	EXTERIOR RECESSED DOWNLIGHT, IP66 RATED
	EXTERIOR RATED, ROUND WITH STRAIGHT HOOD, LED, POLE FIXTURE
	EXTERIOR RATED, ROADWAY RECTANGULAR, LED POLE FIXTURE WITH NEIGHBOR FRIENDLY OPTIC
	EXTERIOR RATED, LINEAR LED LIGHT INTEGRATED HANDRAIL
	EXTERIOR RATED, RECESSED LED STEPLIGHT WITH LOUVERED SHIELDING
	EXTERIOR RATED, SURFACE MOUNTED, RECTANGULAR, LED WALLPACK
	SINGLE PHOTOMETRIC CALCULATION POINT (UNIT IN FOOTCANDLES)
	SOLID LINE INDICATES OUTLINE OF PROPOSED BUILDING
	DASHED LINE INDICATES MATCHLINE BETWEEN ENLARGED SITE AREAS
	DOTTED LINE INDICATES AREAS THAT CORRESPONDS WITH THE LABELS GIVEN TO THE ILLUMINANCE CALCULATION SHOWN IN THE CALCULATION SUMMARY TABLE

DESIGN TEAM

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ISSUED FOR	REV	DATE

GENERAL SHEET NOTES

A. COORDINATE WITH LOCAL UTILITY FOR ALL SITE SERVICE REQUIREMENTS.
B. CONTACT LOCAL UTILITY TO IDENTIFY ALL EXISTING UNDERGROUND UTILITIES.
C. GRAY SHADING INDICATES OUT OF SCOPE AREAS.
D. SEE HARDSCAPE DETAILS FOR POLE MOUNTED FIXTURE TYPE SERIES S1 AND S2 MOUNTING DETAILS.
E. SITE ILLUMINATION DESIGNED TO IESNA STANDARDS.

KEYNOTES

KEYPLAN:

SHEET TITLE: **ELECTRICAL SITE PLAN AREA D**

PROJECT NUMBER: 12543.000

MR-10.10

MANDATORY REFERRAL NO. MR2019011

Plot Date: 12/14/2018 11:16:13 AM Author



1 ELECTRICAL SITE PLAN - AREA D
SCALE: 1" = 10'-0"